
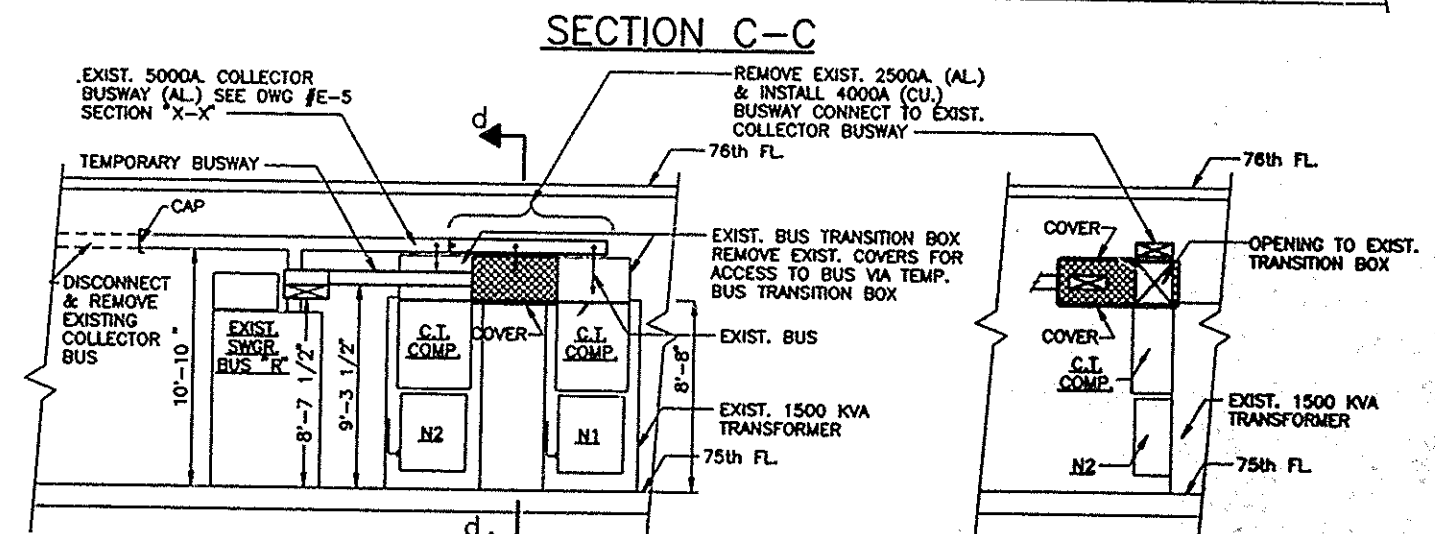
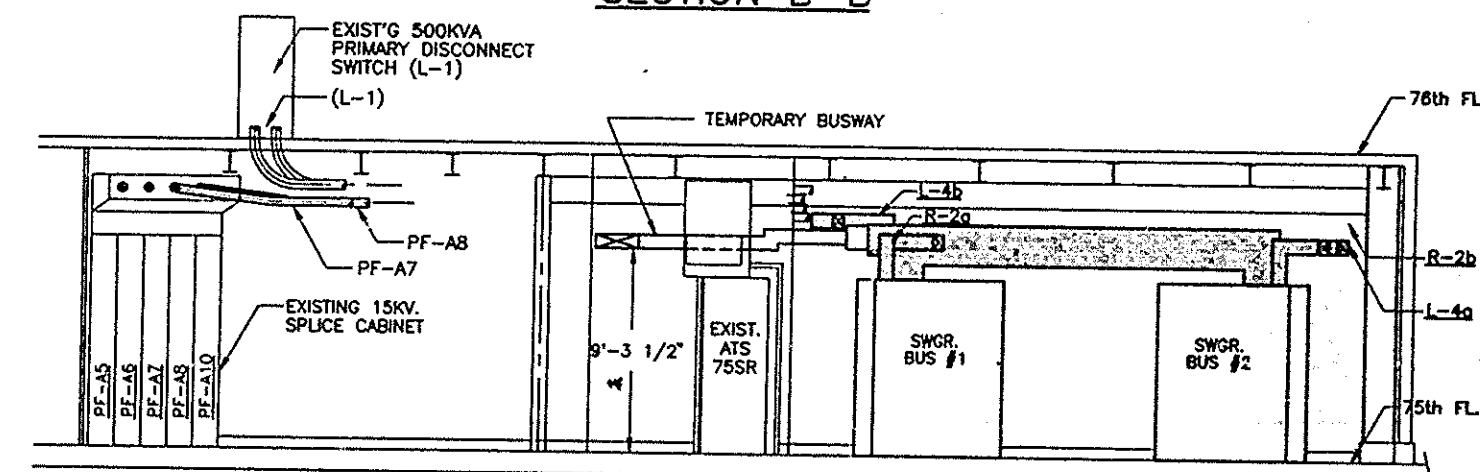
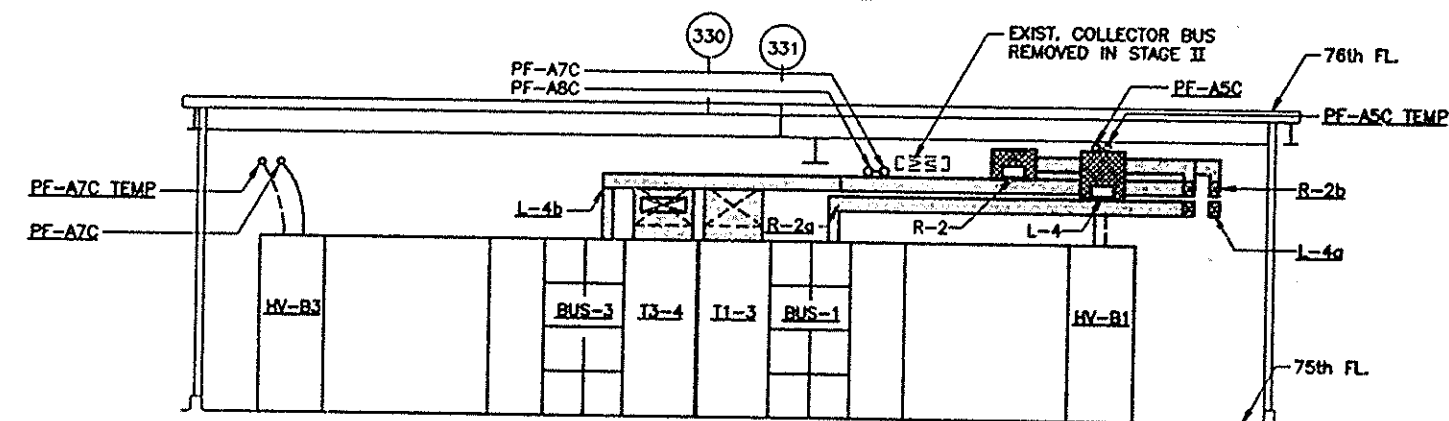


PART PLAN 75th FLOOR

SCALE IN FEET

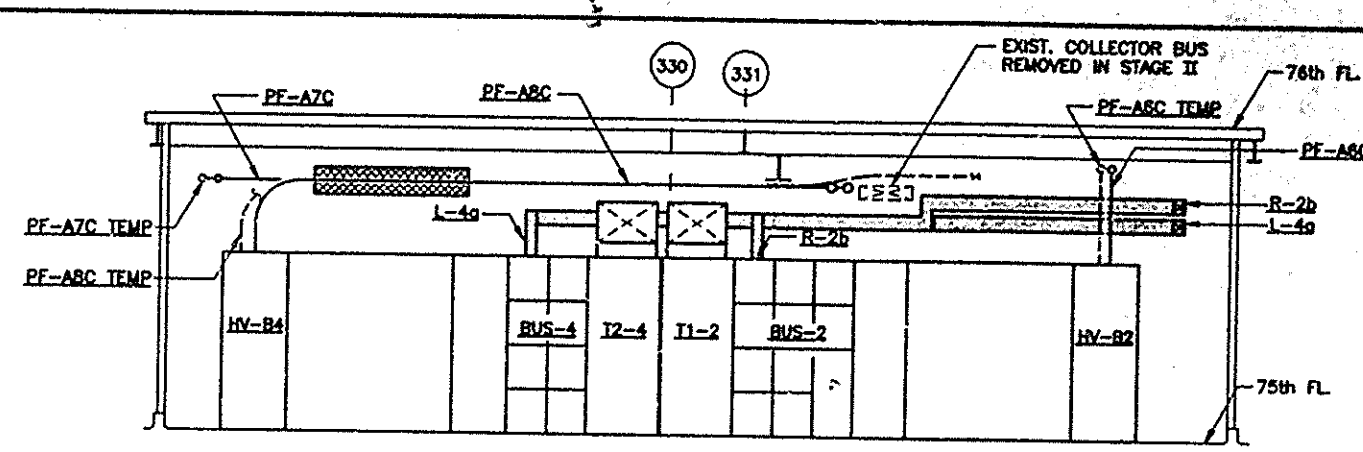

SECTION d-d

NOTE:

1. THIS DRAWING SHOWS BOTH STAGE II AND III WORK COMBINED. FOR SEPARATION OF WORK SEE NOTE #3 DRAWING #E-53.
2. FOR WORK IN THE ELECTRIC CLOSET "C" SEE DRAWING #E-40, SS-75N ONE LINE DIAGRAM.
3. FOR LOCAL CONTROL PANEL DETAILS SEE DRAWING #E-107.
4. FOR BUSWAY REQUIREMENTS SEE DWG. #E-2 GENERAL NOTE #17.

THE PORT AUTHORITY OF NY & NJ

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TOWER ONE AND TWO  
LOW VOLTAGE  
SUBSTATIONS  
CONSTRUCTION AND  
INSTALLATION

ELECTRICAL  
SUBSTATION SS-75S  
STAGE II AND III  
SWITCHGEAR EQUIPMENT  
PLAN & SECTIONS

No.	Date	Revision	Approved
1	6/21/95	1	LEWY/FISCHER
2	8/15/95	2	Peter K. Sweeney

This drawing is subject to conditions in contract. All inventions, ideas, designs and methods herein are reserved by Port Authority and may not be used without its written consent.

Designed by: LEWY/FISCHER  
Drawn by: LEWY  
Checked by: LEWY

Date: 5-1-95  
Scale: AS NOTED

Contract Number: WTC 802.071  
Drawing Number: E-56